


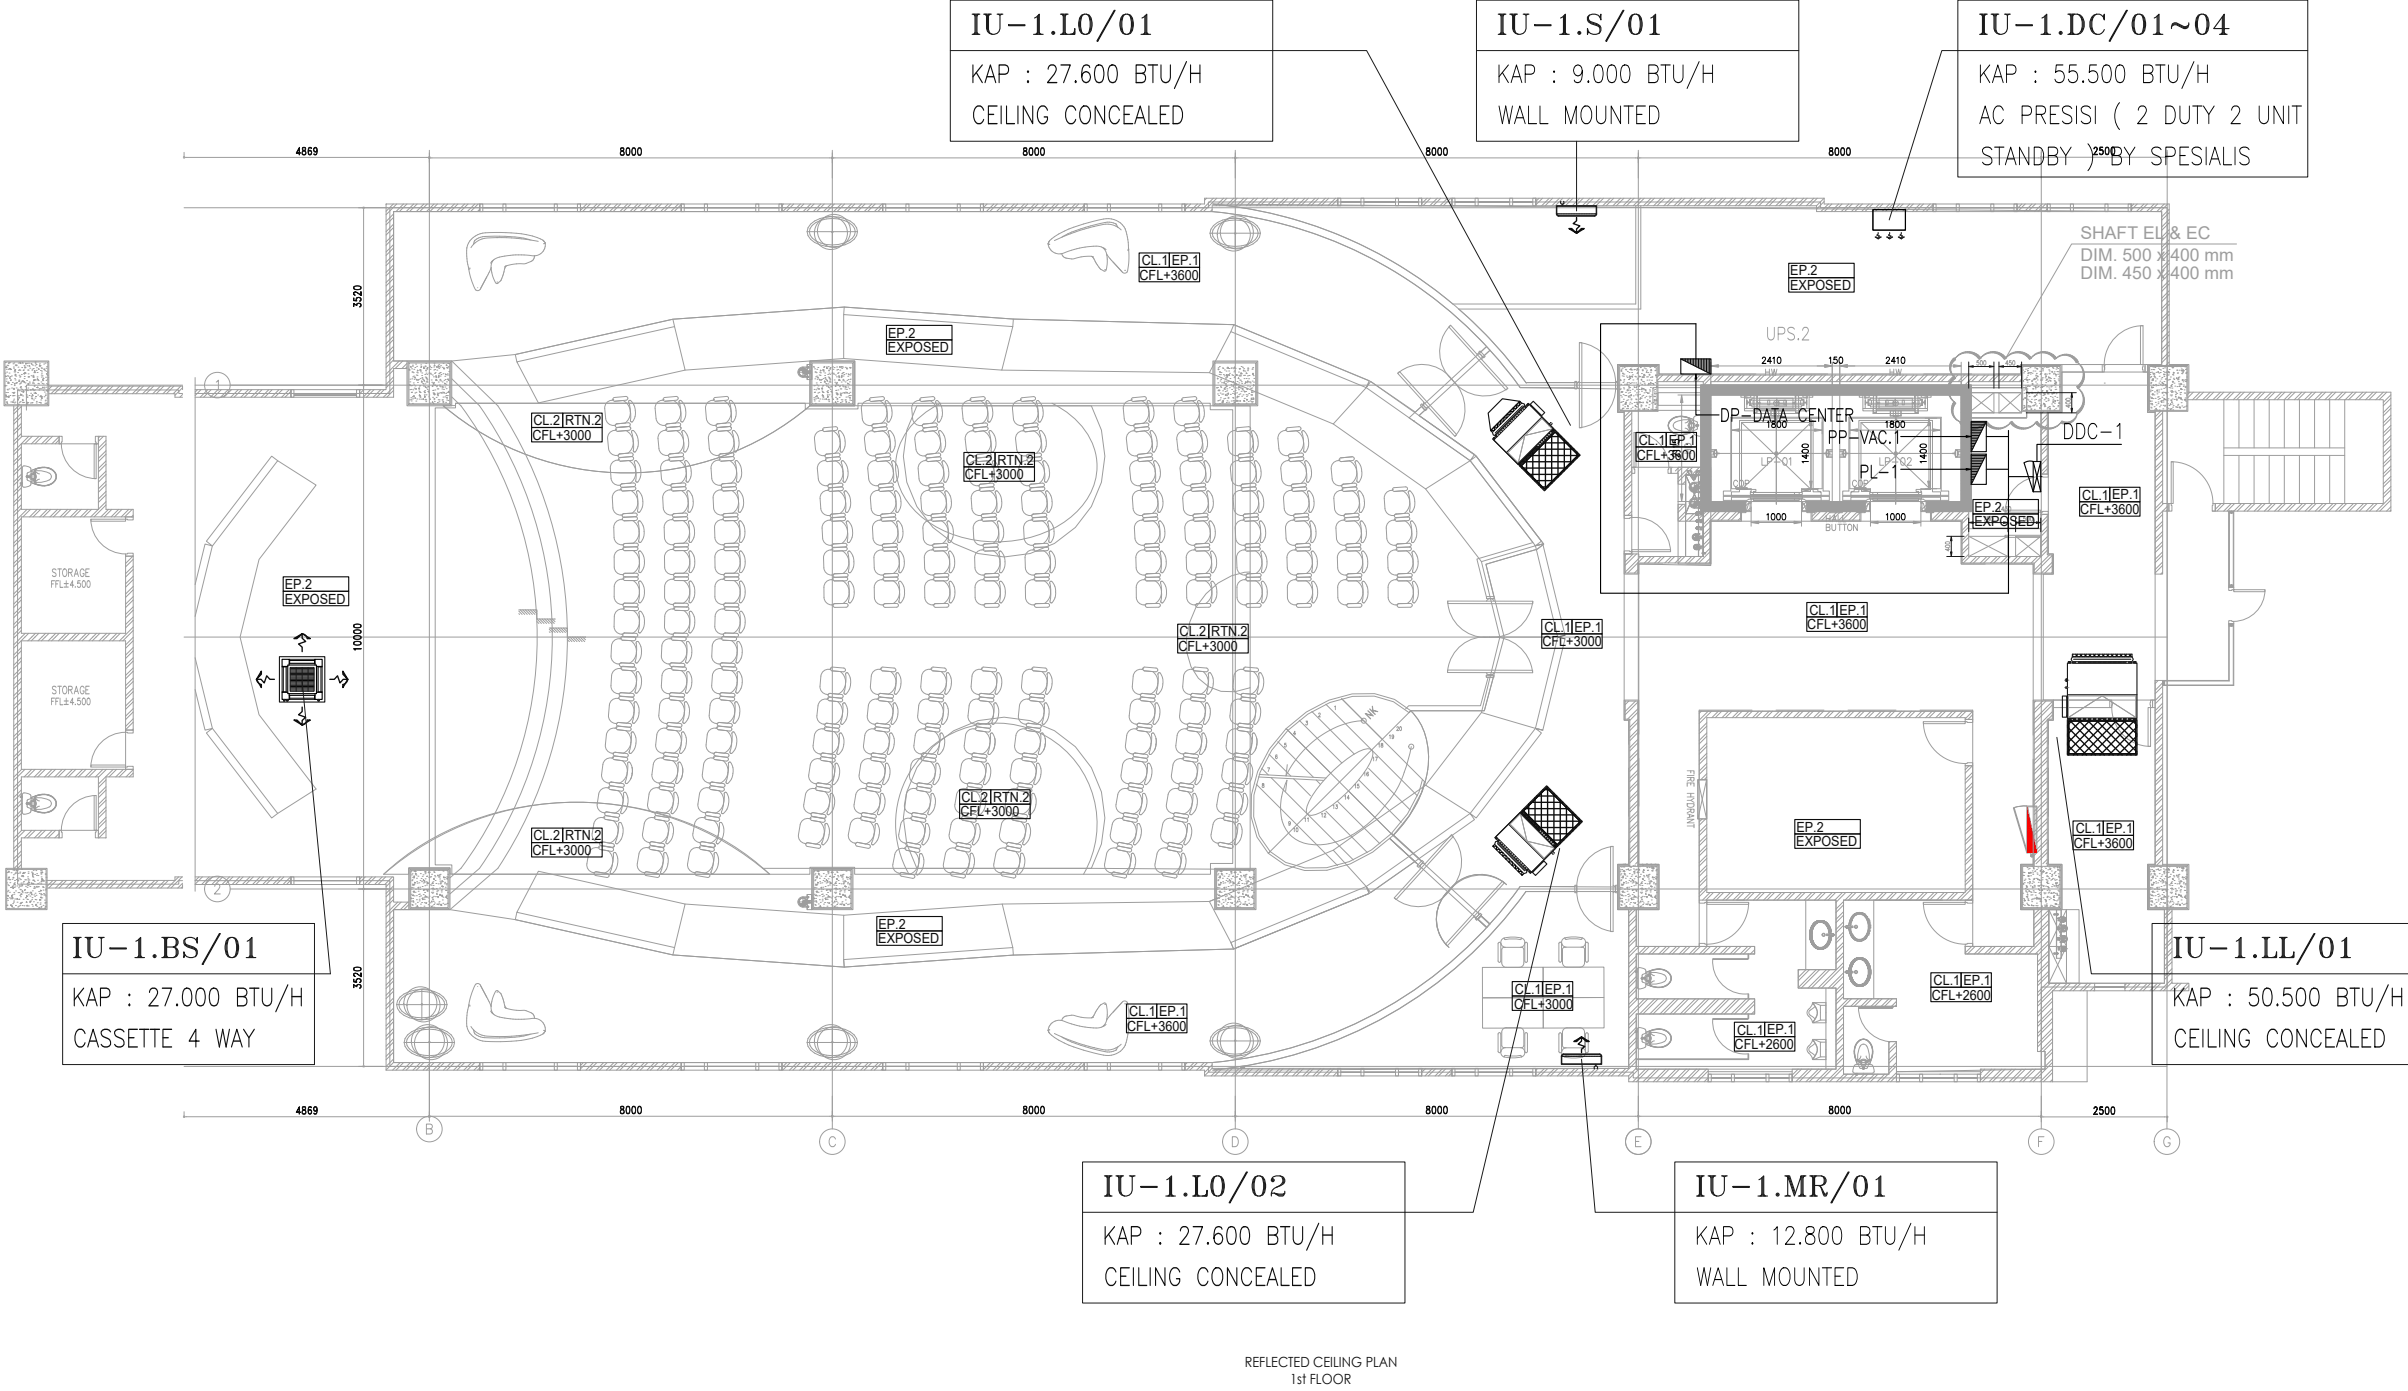






KETERANGAN :

PL	= PANEL PENERANGAN
PP	= PANEL POWER
DP	= DISTRIBUTION PANEL
DDC	= DIGITAL DIRECT CONTROLLER



REFLECTED CEILING PLAN  
1st FLOOR

<div>OWNER/CLIENT</div> <div></div> <div>APPROVED : .../.../...</div> <div><div>..... (name)</div><div>..... (position)</div><div>(signed) ..... (Dep./Div.)</div></div>	<div>PROJECT</div> <div>BPDP KELAPA SAWIT</div> <div>Jl. Medan Merdeka Tim, RT.7/RW.1, Gambir, Kec. Gambir, Kota Jakarta Pusat, Daerah Khusus Ibukota Jakarta 10110</div>	<div>INTERIOR DESIGN CONSULTANT</div> <div>PT. MADEA AGKASAMA</div> <div>Jl. Hati Suci No. 4 Gd. Sakura Lt. 2 Room 201 Kel. Kampung Bali, Kec. Tanah Abang, Jakarta Pusat Telp. 021 - 2303483 , Fax. 021 - 2303483 APPROVED : //</div>	<div>MEP CONSULTANT</div> <div><div>PT. DUTA PRATAMA ENGINEERING MECHANICAL &amp; ELECTRICAL ENGINEER</div><div><small>Rukan Taman Meruya Blok M No. 37, J. Batu Mulia No. 1 Meruya Utara Kembangan – Jakarta Barat 11620 Phone : 021-5845546, 5845547, 5845556, Fax : 021-58474531 Email : dpeptline@gmail.com, ptidpe.me@yahoo.com</small></div></div>	<div>DRAWING TITLE</div> <div>DENAH INSTALASI BMS LANTAI 1</div> <div>SCALE : 1:150</div> <div>ALL MEASUREMENT MUST BE CHECKED AT BY SITE BY THE CONTRACTORS AND ANY DIFFERENCES REPORTED/INITIATED TO THE DESIGNER FOR CLARIFICATION BEFORE PROCEEDING.</div>	<div></div> <div>...</div> <div>.../.../...</div>	<div>DRAWN</div> <div>Denny</div> <div>DATE : 15/05/24</div>	<div>DRAWING NUMBER</div> <div>EC-402</div>
					<div></div> <div>...</div> <div>.../.../...</div>	<div>CHECKED</div> <div>Widodo</div> <div>DATE : 15/05/24</div>	<div>PAGE</div>
					<div></div> <div>...</div> <div>.../.../...</div>	<div>DRAWING FOR</div> <div>TENDER</div>	
					<div></div> <div>...</div> <div>.../.../...</div>	<div>DATE : 2024/05/10</div>	
					<div></div> <div>...</div> <div>.../.../...</div>		
					<div>#</div> <div>REVISION :</div> <div>DATE</div>		